




of the Carolinas N.C.B.E.L.S. License No. F-0116

101 N. 3rd Street, Suite 201 Wilmington, NC 28401-4034 910.398.9020

HDR Engineering, Inc.

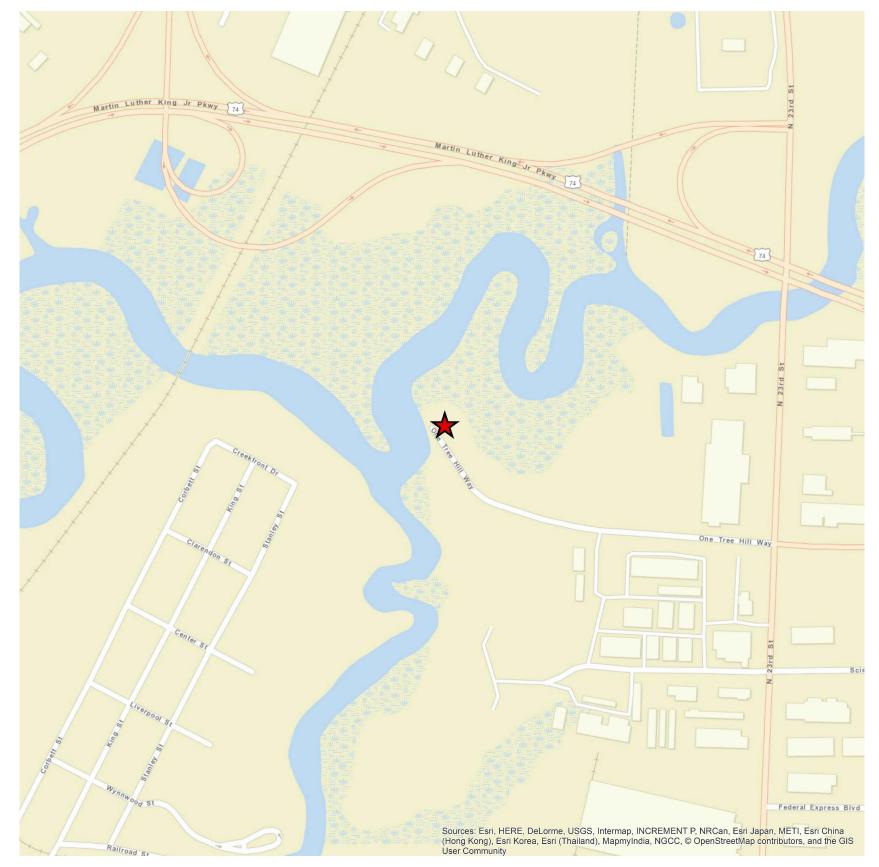

VICINITY MAP

Contract Drawings For


# Pump Station #10 Replacement


### ISSUED FOR CONSTRUCTION

NC DWI Project No. E-SRP-W-17-0029


HDR Project No. 000000010075083

Wilmington, NC February 2019

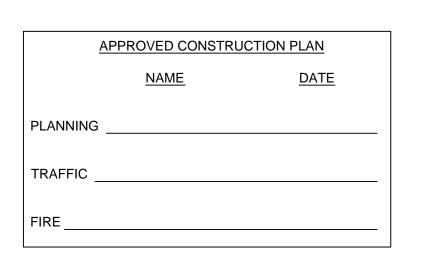

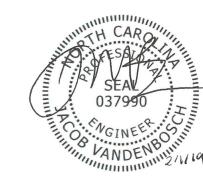



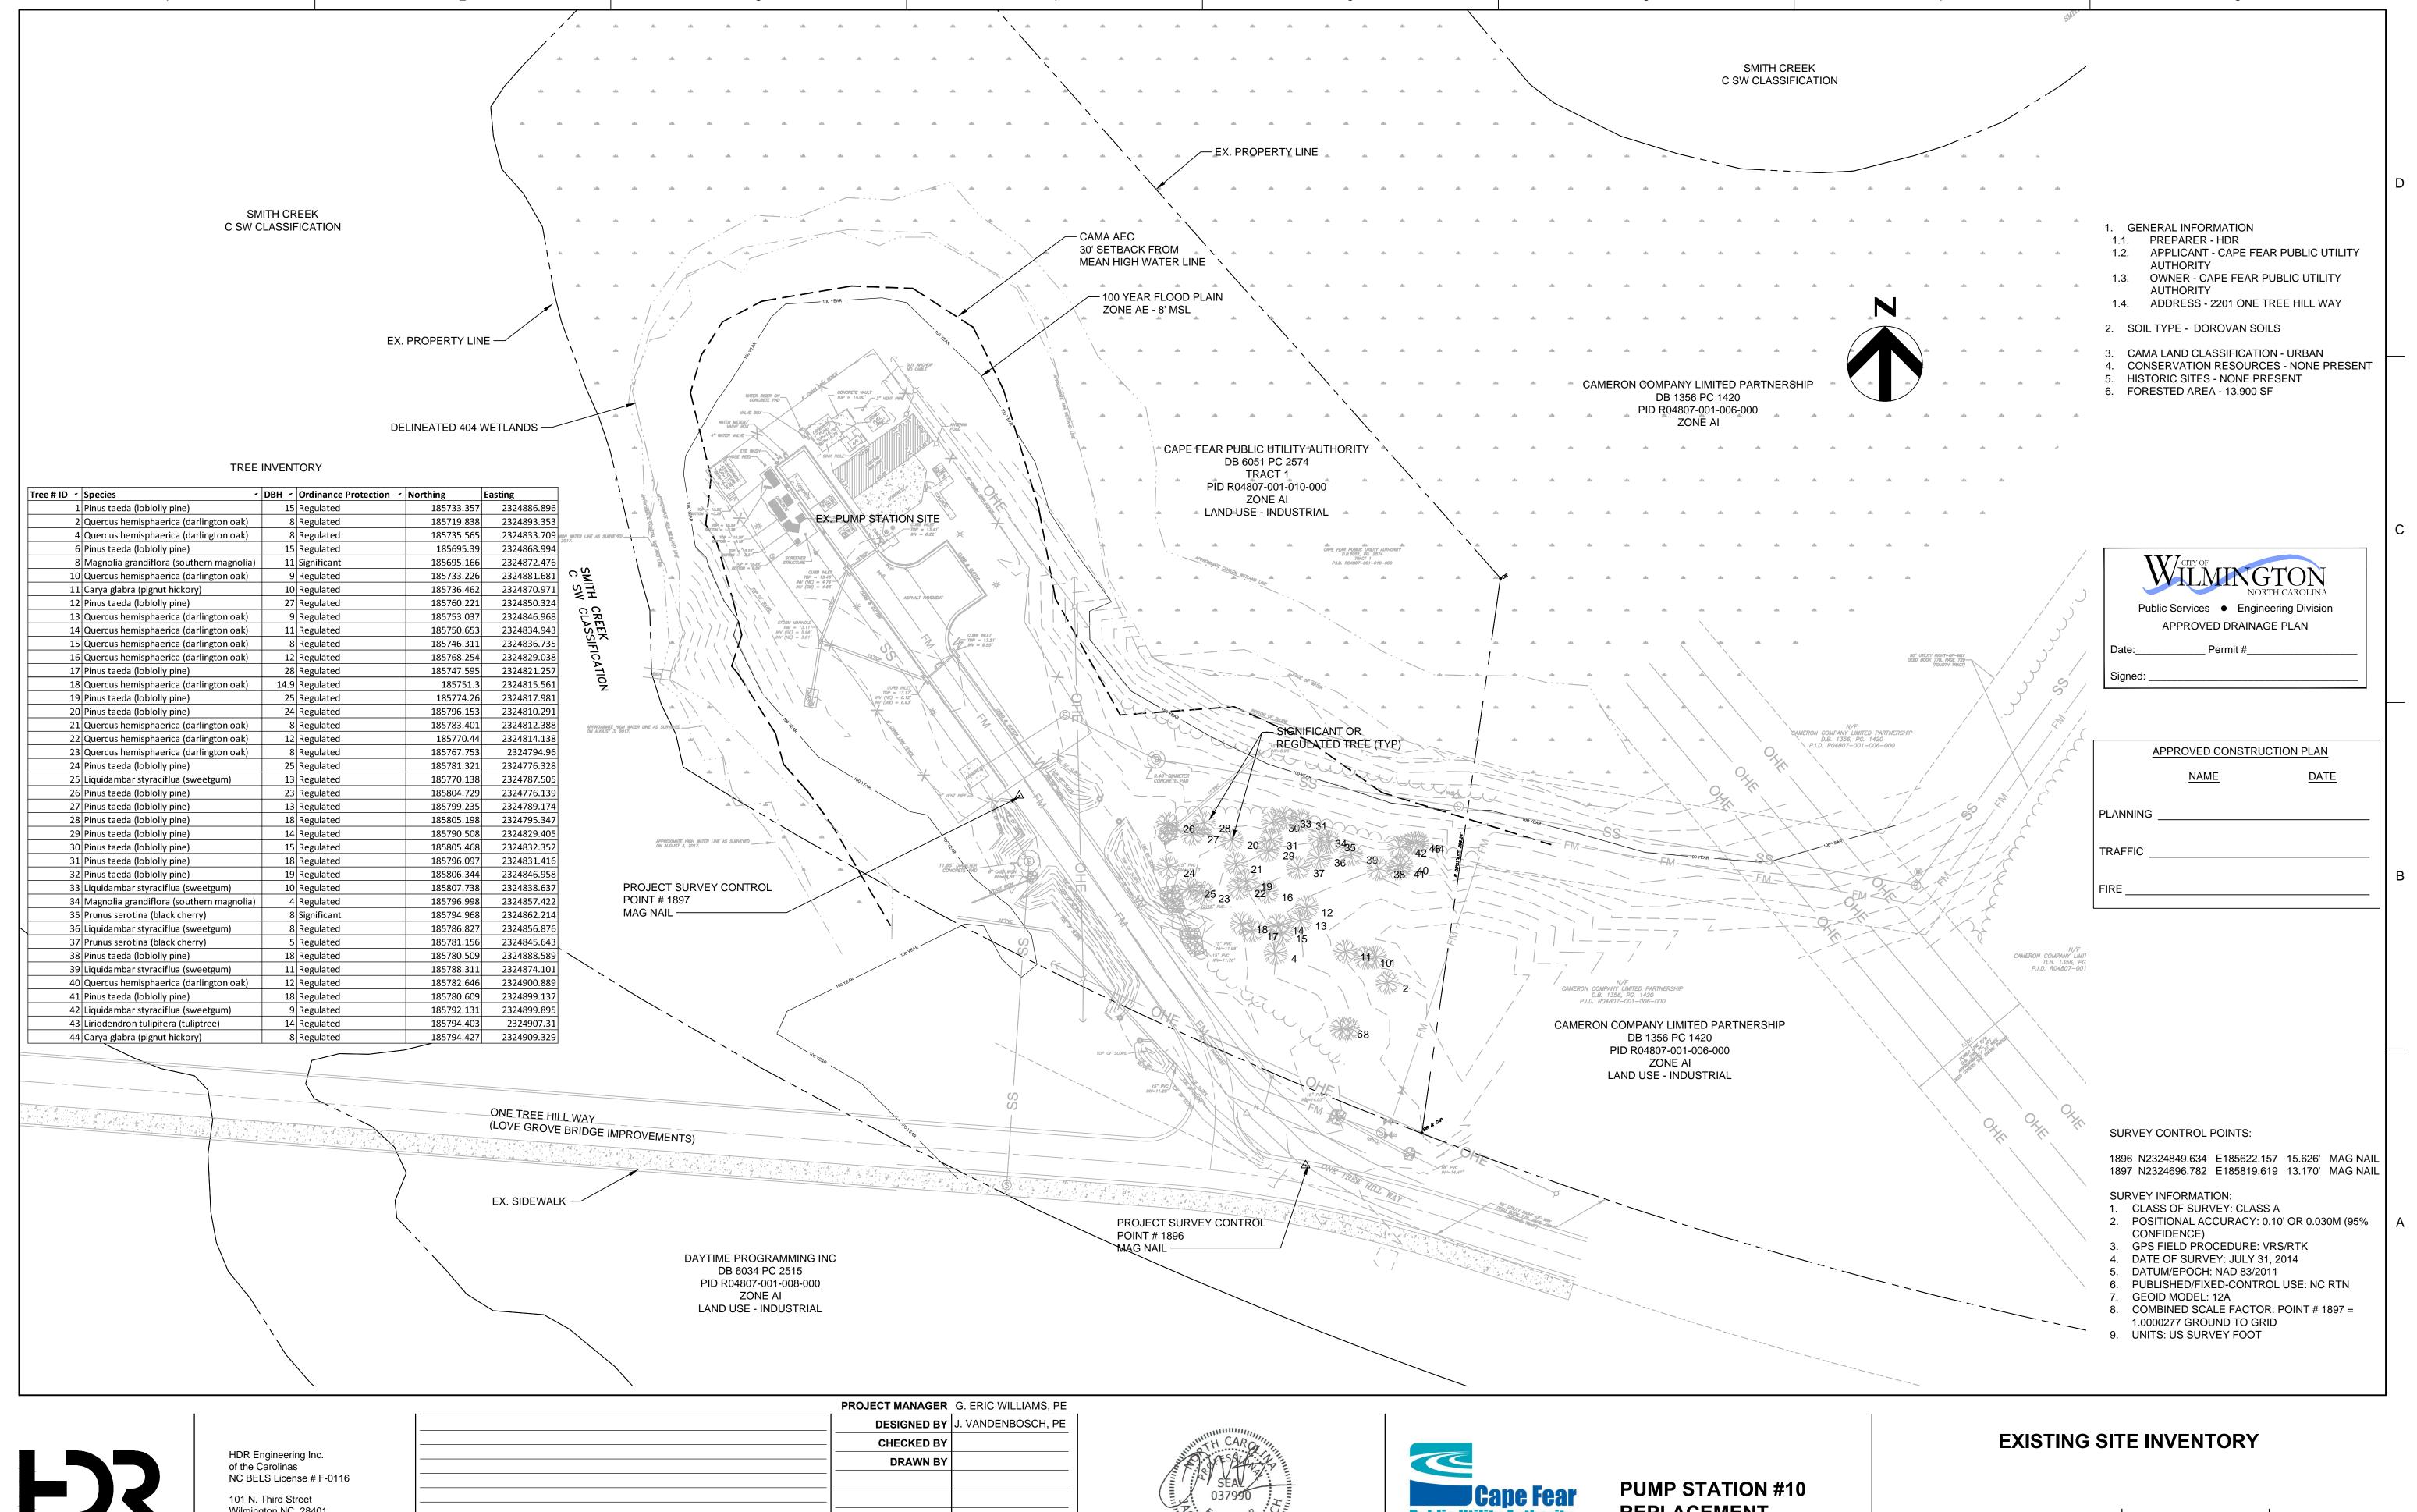



Wilmington NC, 28401 910-398-9020

ISSUE	DATE	DESCRIPTION	PROJECT NUMBER	100075083
0	10/2018	ISSUED FOR CONSTRUCTION		
			DRAWN BY	
			DD AMAL DV	
			CHECKED BY	
				1






**REPLACEMENT** 



SHEET FILENAME 00V-01B.dwg

**SCALE** 1" = 40'


01V-01

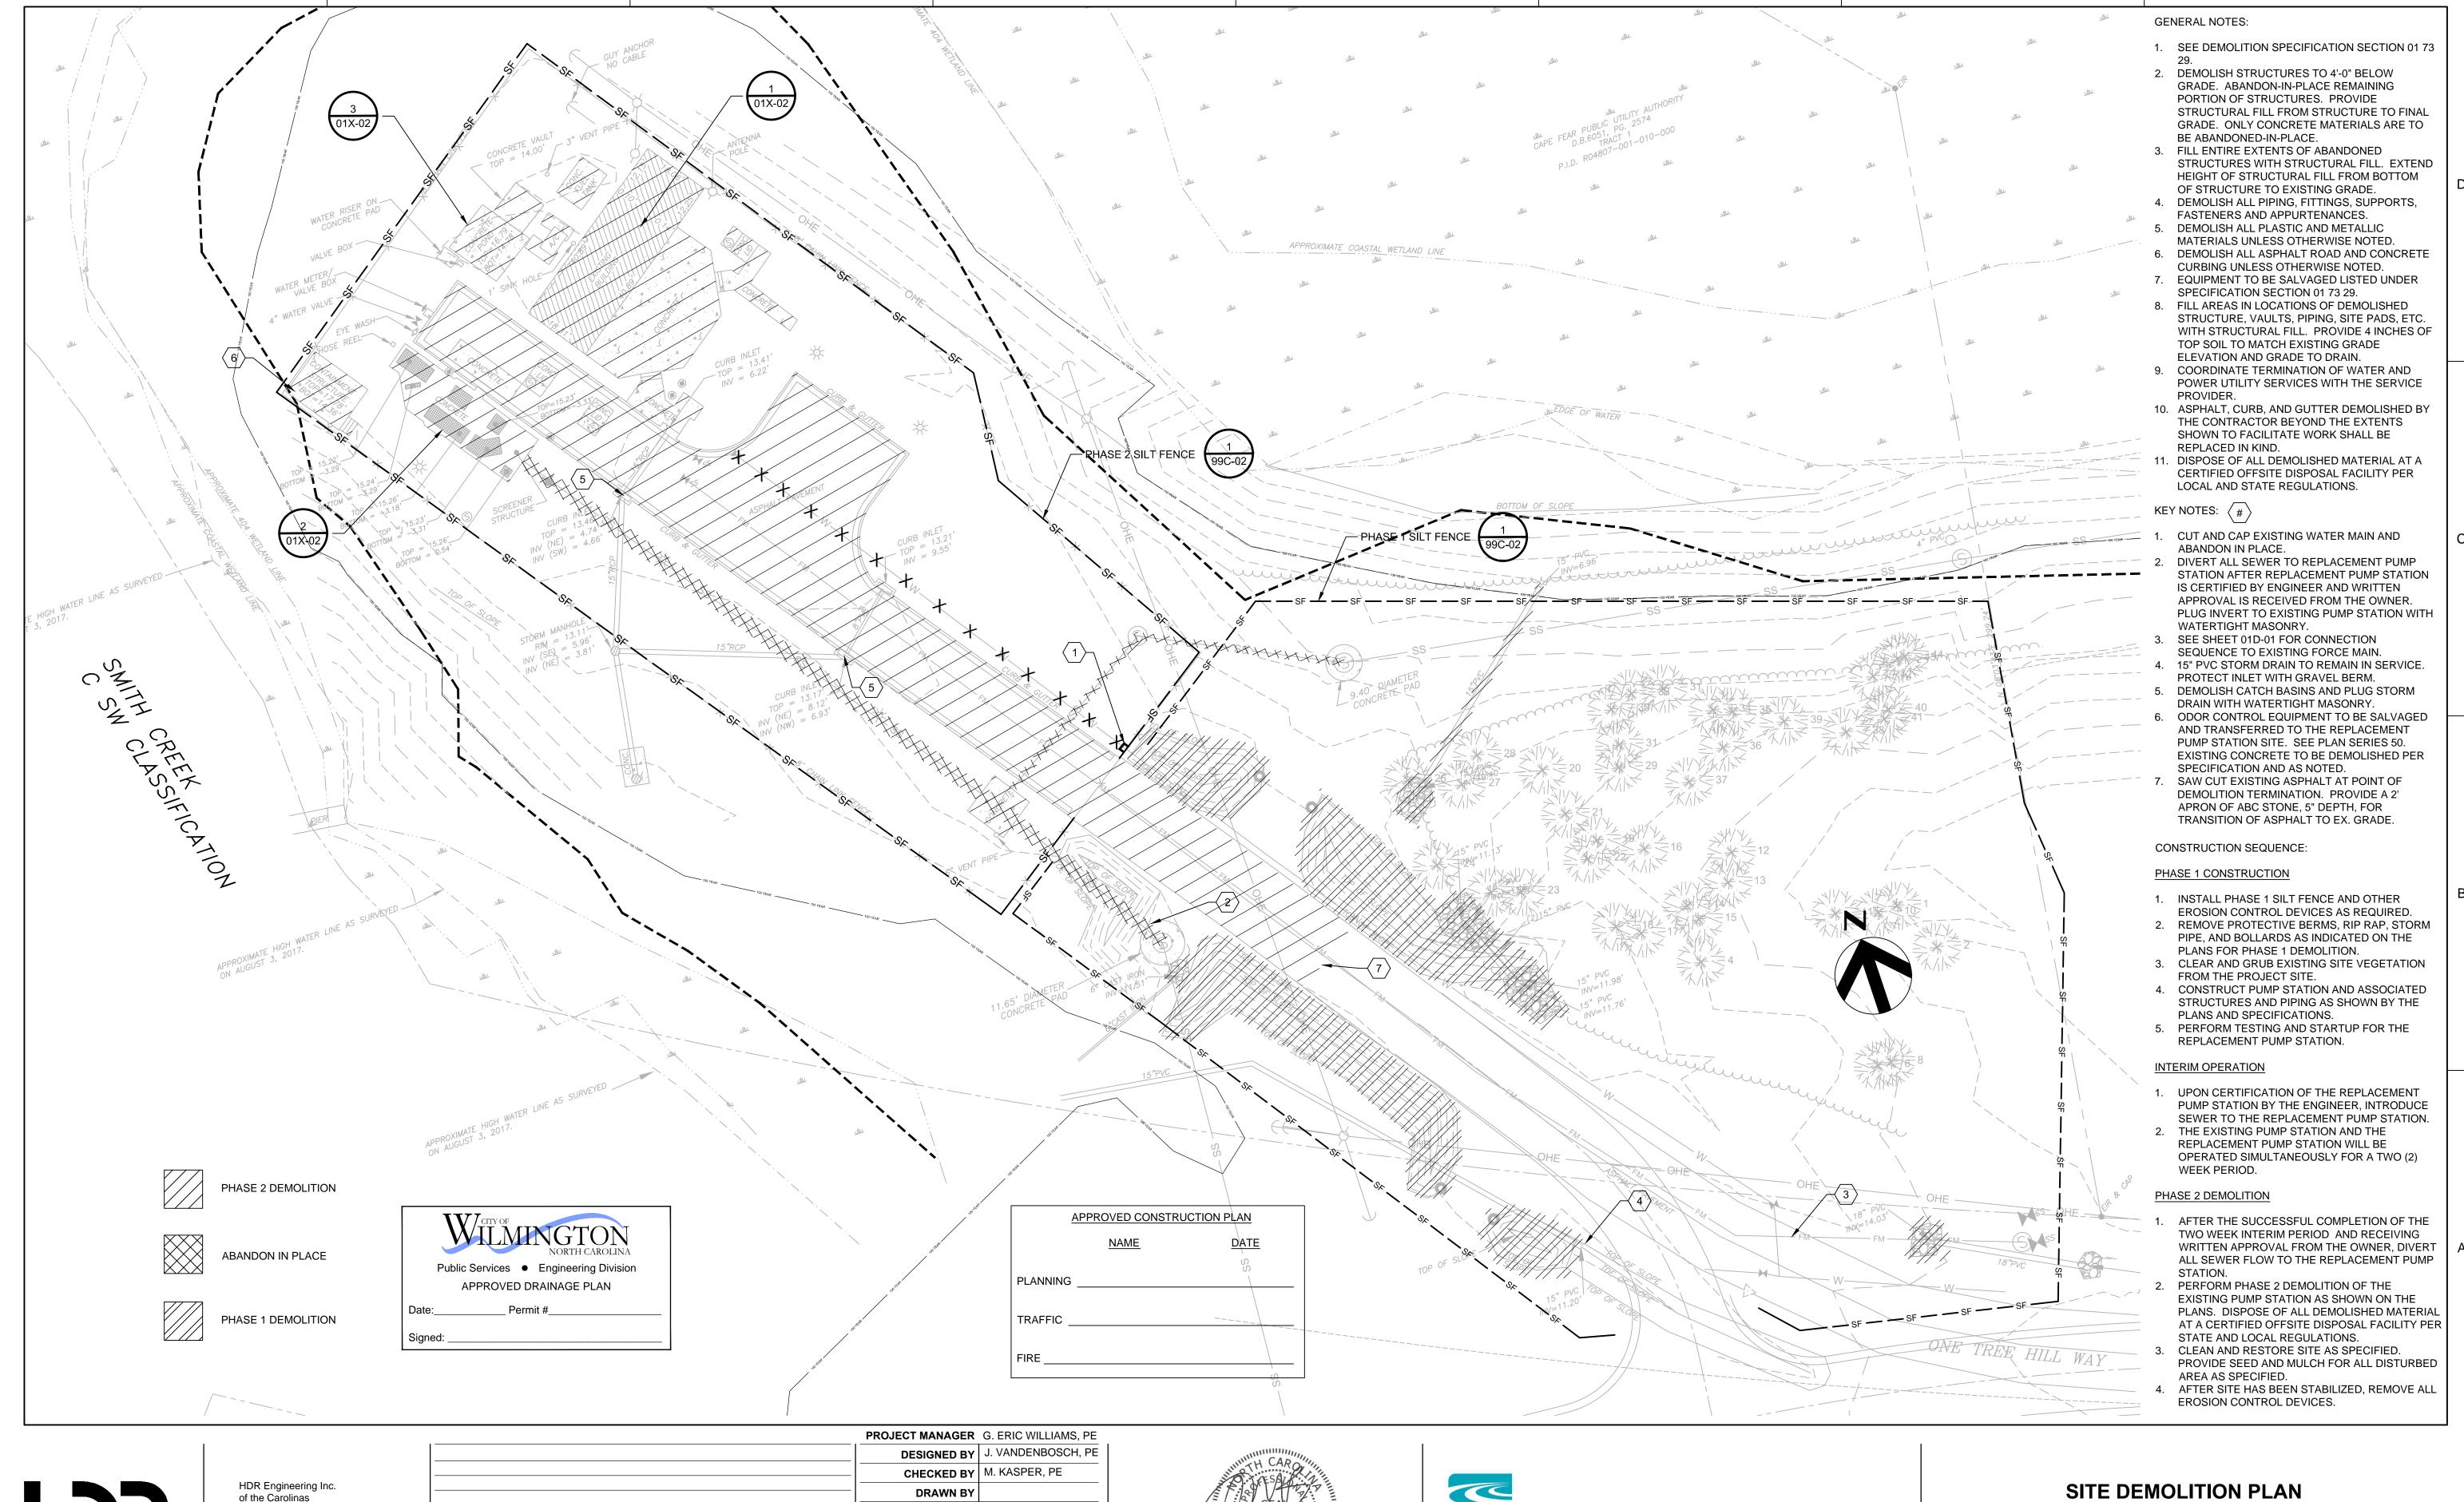



HDR Engineering Inc. of the Carolinas NC BELS License # F-0116 101 N. Third Street Wilmington NC, 28401 910-398-9020

ISSUE	DATE	DESCRIPTION	PROJECT NUMBER	100075083
0	10/2018	ISSUED FOR CONSTRUCTION		
			DRAWN BY	
			CHECKED BY	M. KASPER, PE
			DESIGNED BY	J. VANDENBOSCH, PE

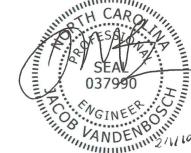




PUMP STATION #10 REPLACEMENT



FILENAME 00X-01.dwg

**SCALE** 1" = 20'

01X-01

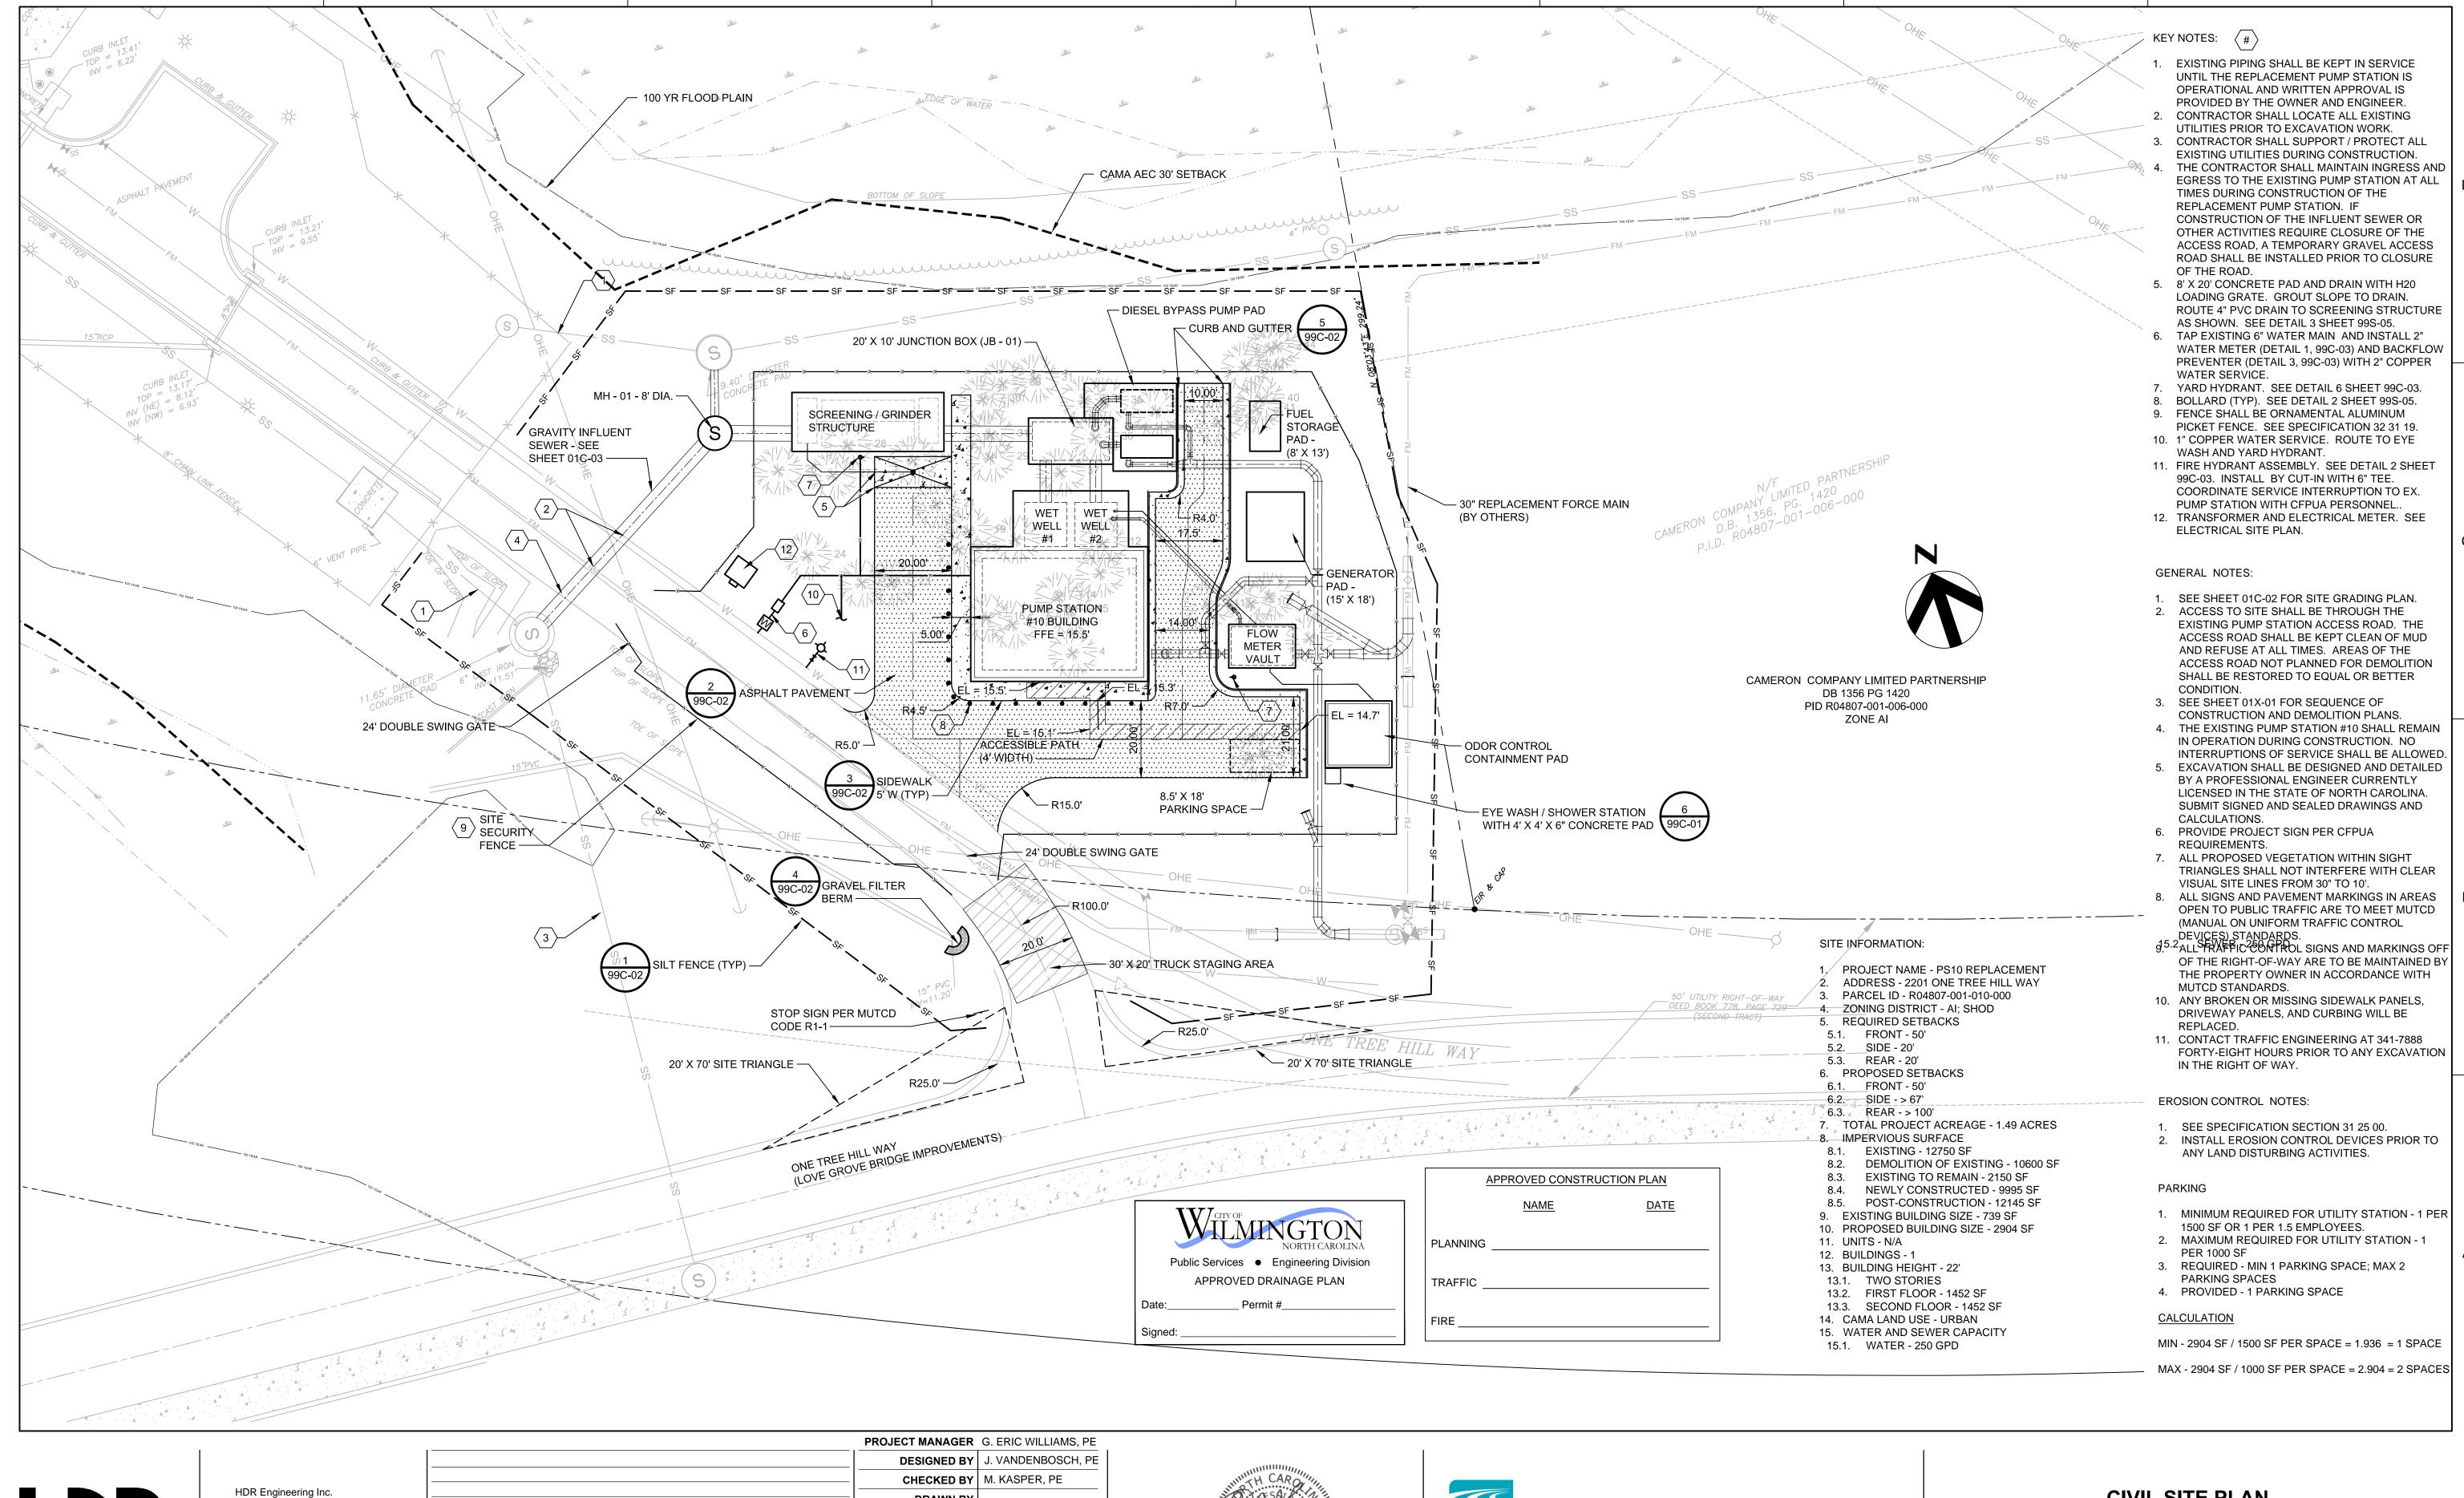



of the Carolinas

910-398-9020

**DRAWN BY** NC BELS License # F-0116 101 N. Third Street Wilmington NC, 28401 ISSUED FOR CONSTRUCTION DATE DESCRIPTION PROJECT NUMBER | 100075083






**PUMP STATION #10 REPLACEMENT** 

## **CIVIL SITE PLAN**



FILENAME 00C-01B.dwg


SHEET 01C-01

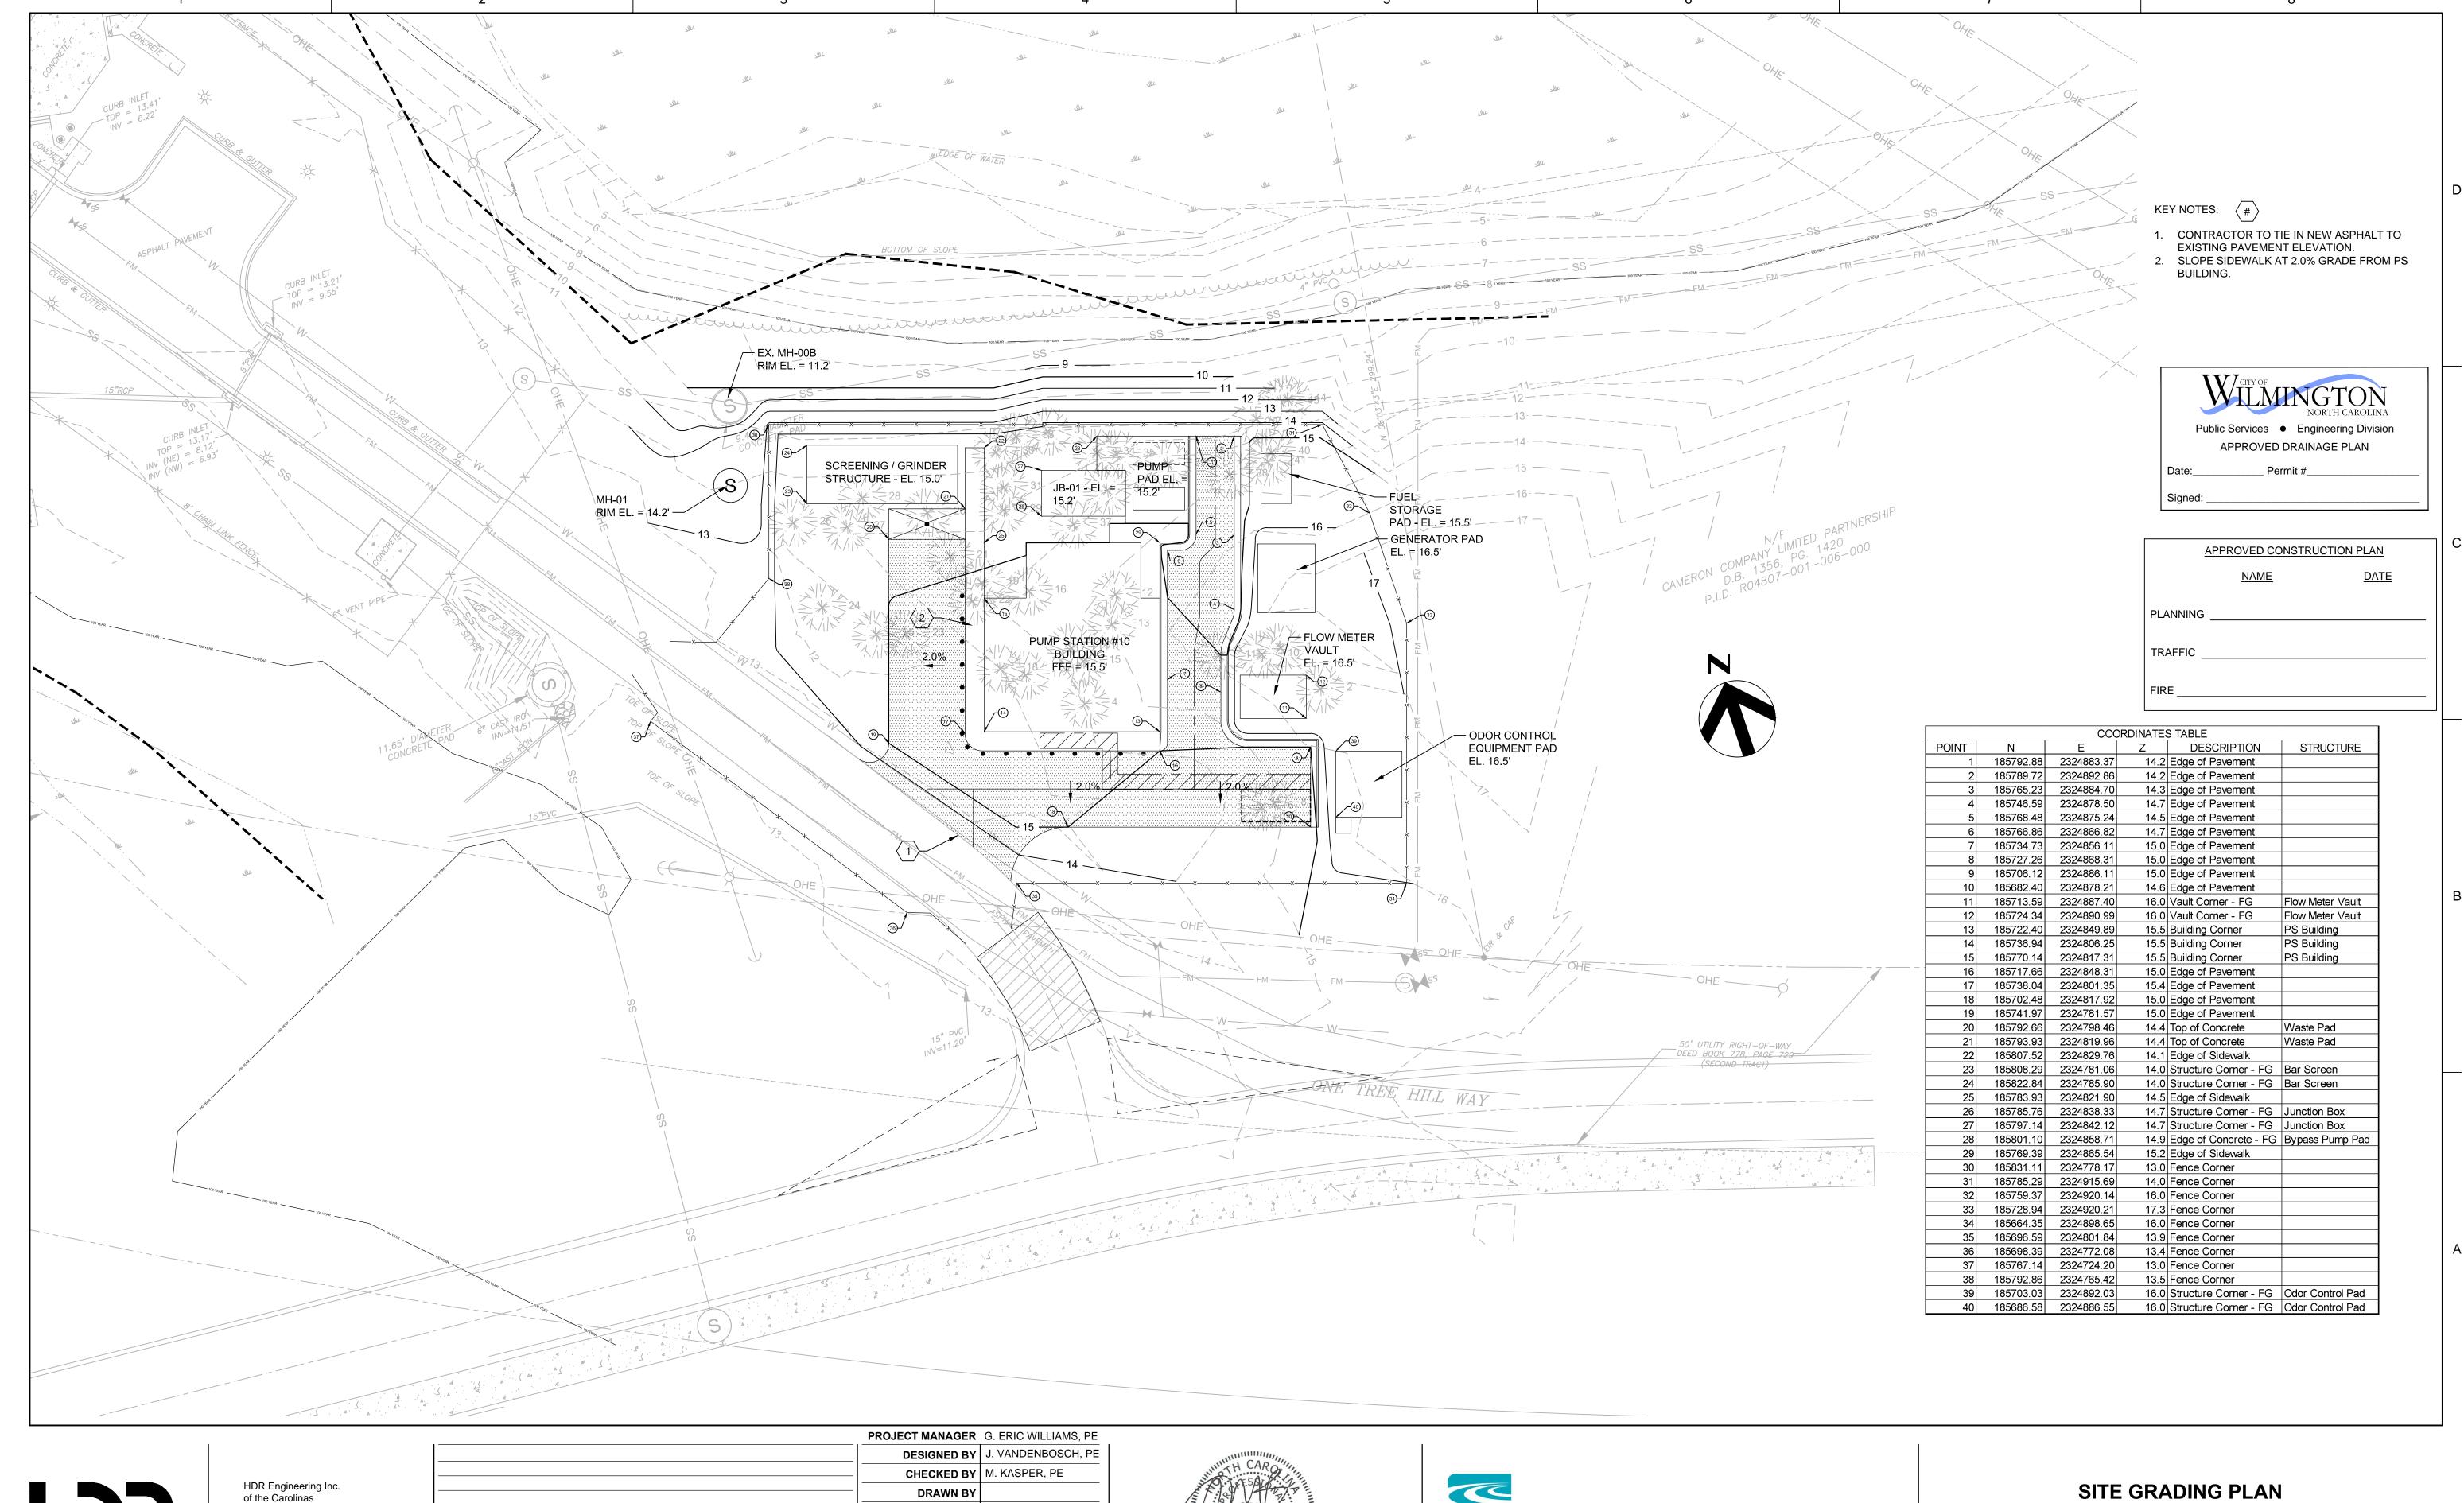



of the Carolinas NC BELS License # F-0116 101 N. Third Street Wilmington NC, 28401 910-398-9020

			DESIGNED BY	J. VANDENBOSCH, PE
			CHECKED BY	M. KASPER, PE
			DRAWN BY	·
0	10/2018	ISSUED FOR CONSTRUCTION		
ISSUE	DATE	DESCRIPTION	PROJECT NUMBER	100075083

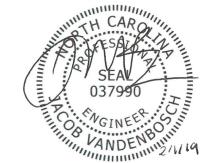




**PUMP STATION #10 REPLACEMENT** 



**SCALE** 1" = 20'



SHEET 01C-02

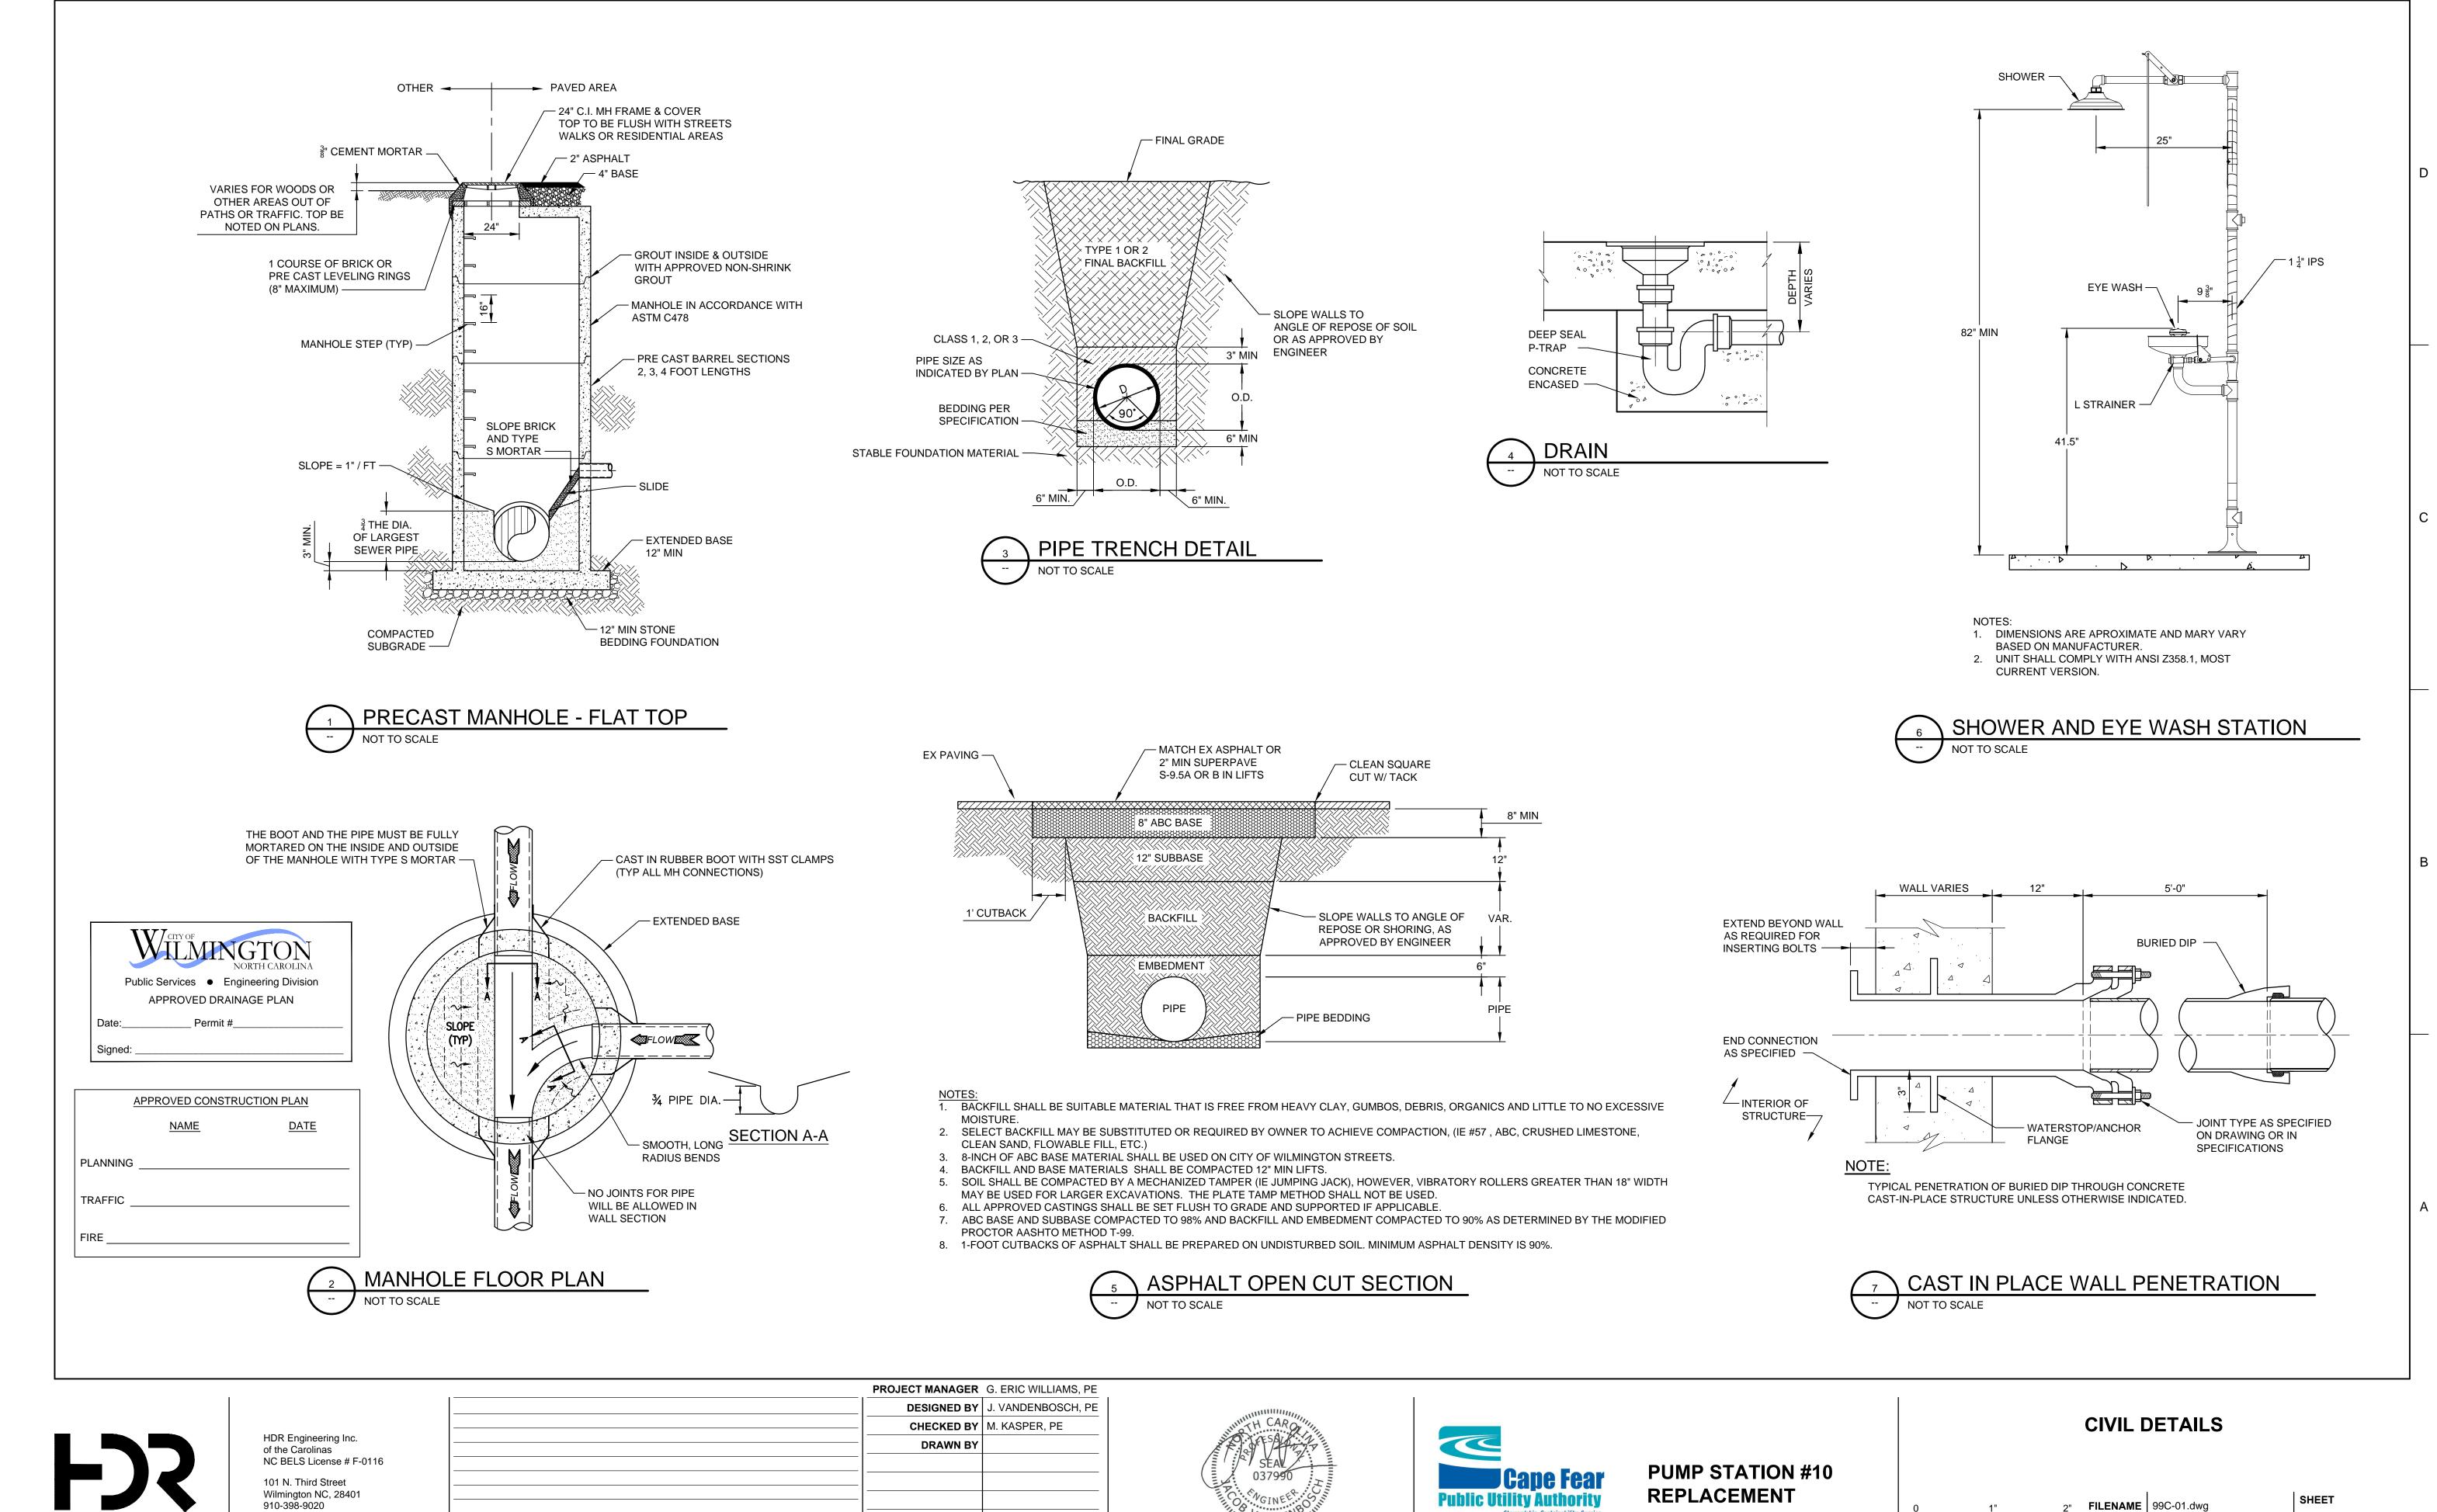

ISSUED FOR CONSTRUCTION


PROJECT NUMBER | 100075083

DESCRIPTION

DATE

99C-01

**SCALE** 1/4" = 1'0"

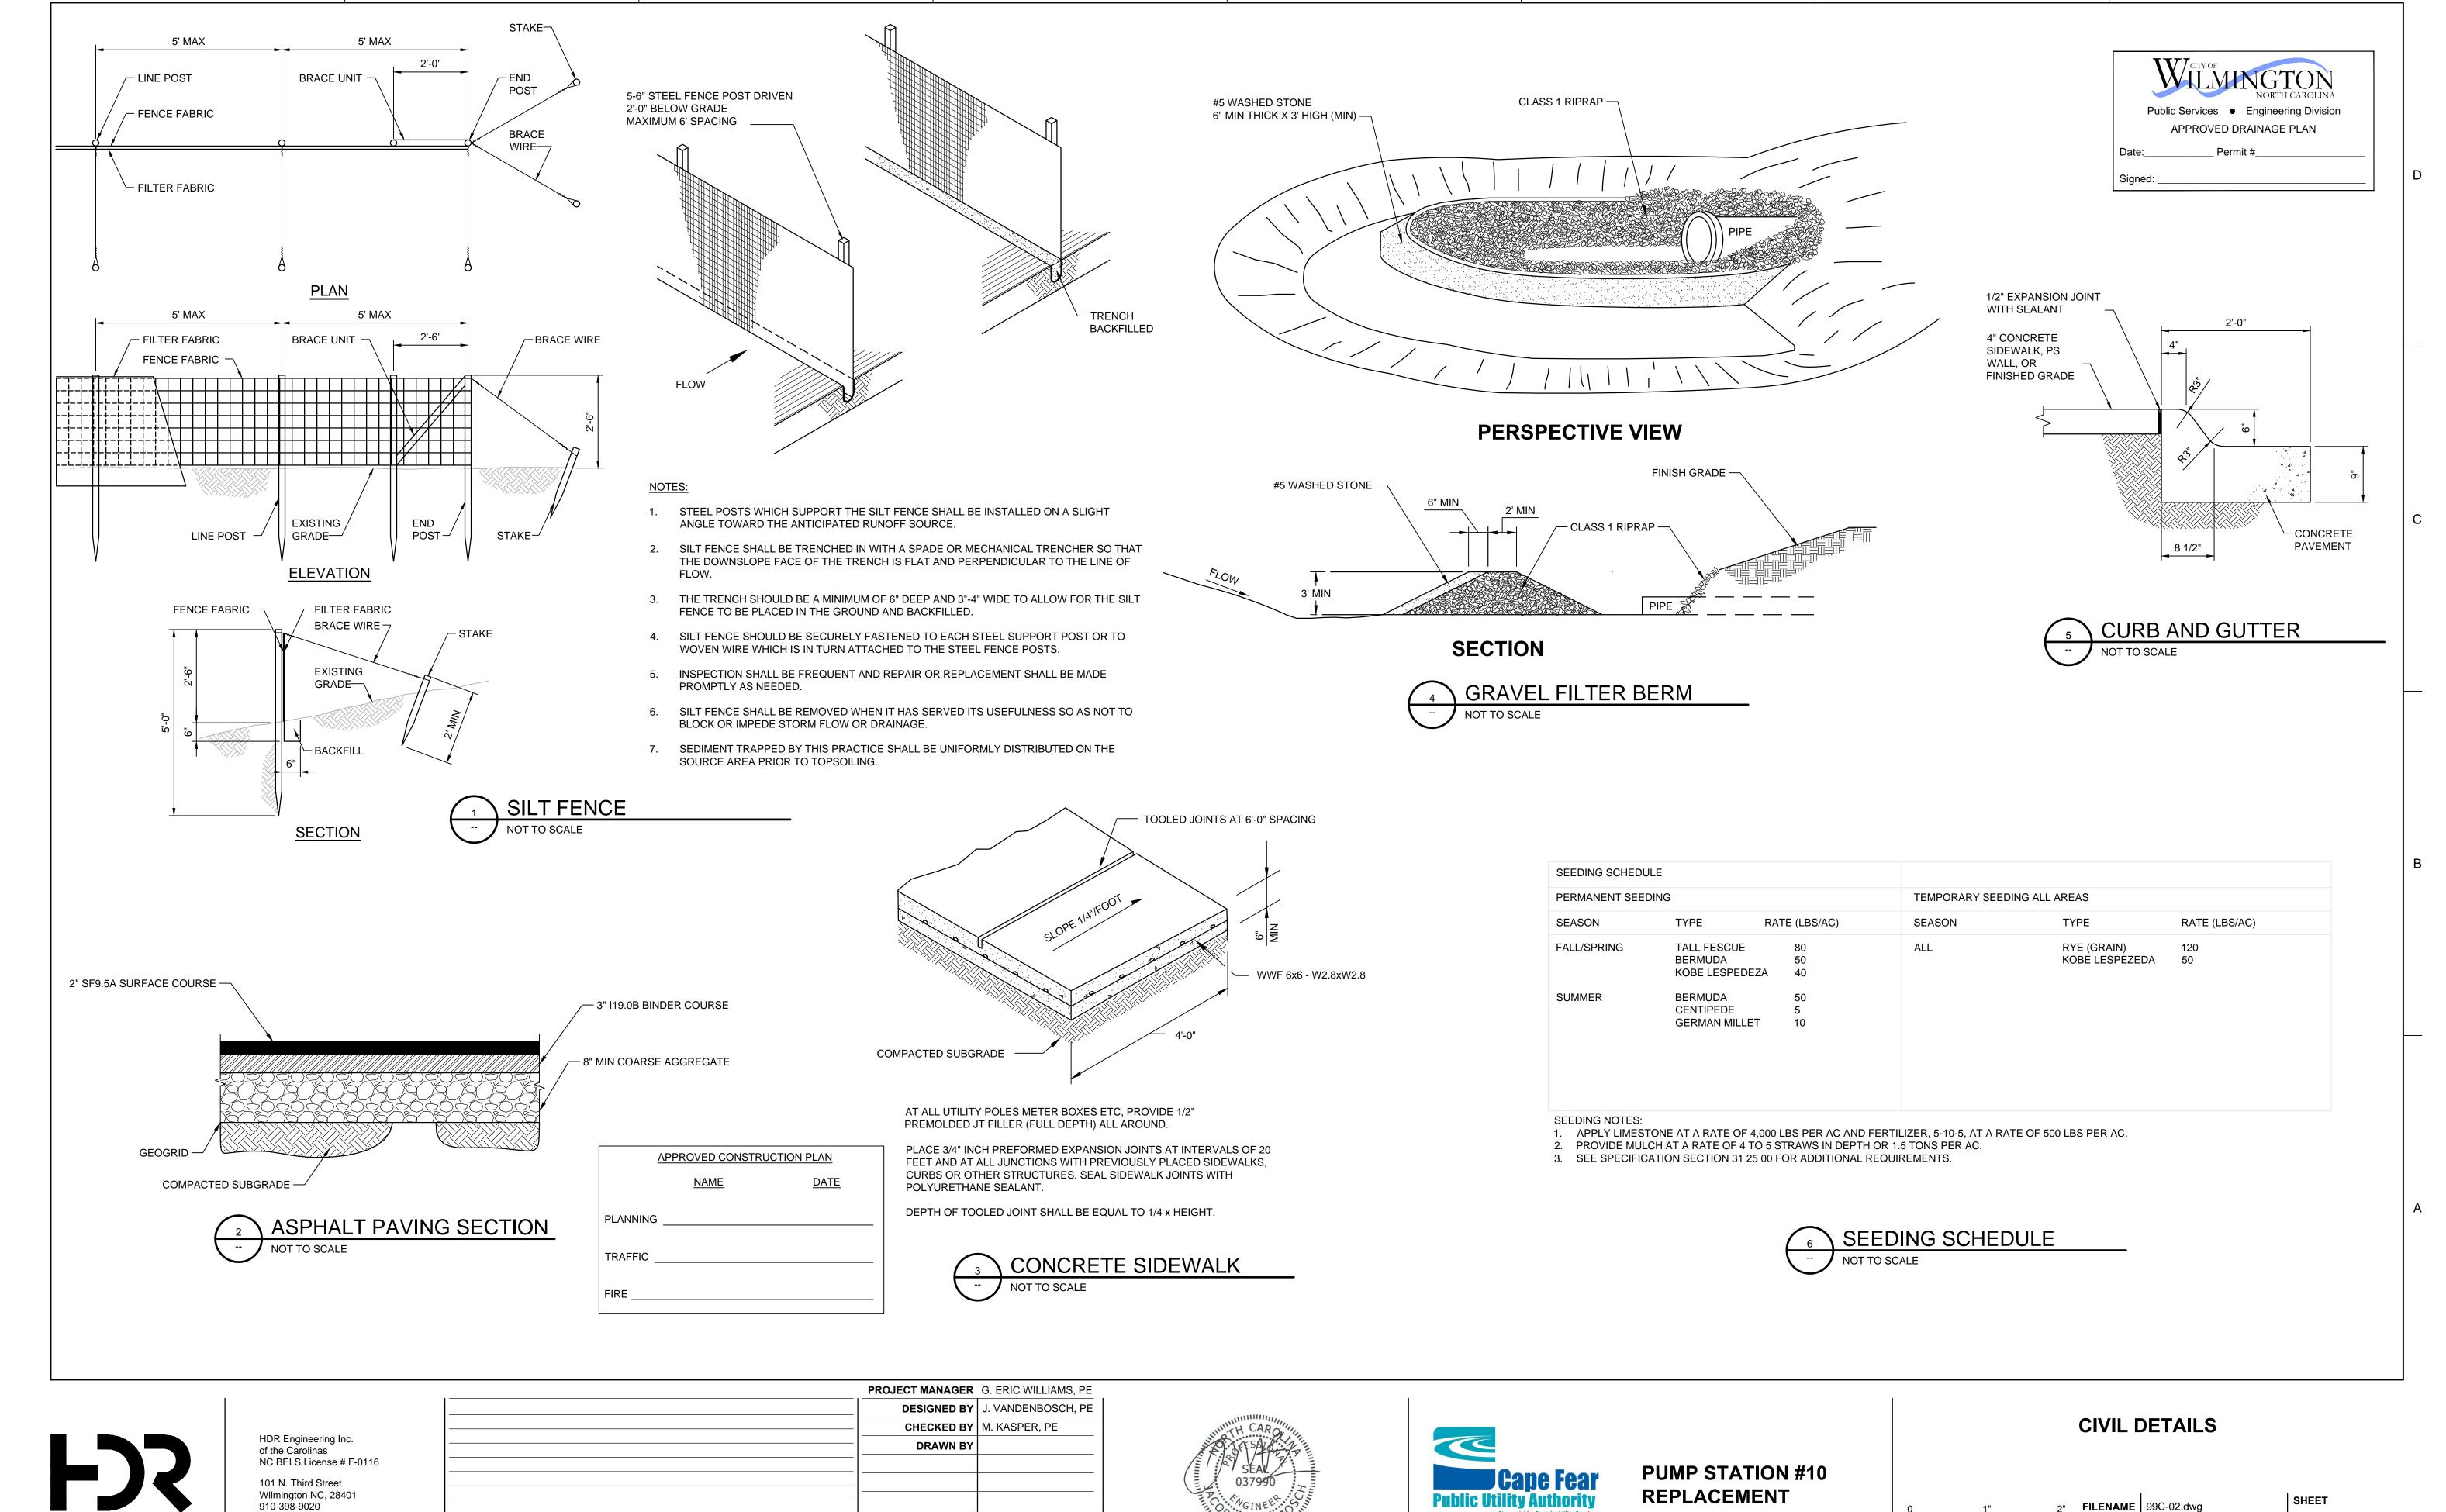

ISSUED FOR CONSTRUCTION


PROJECT NUMBER | 100075083

DESCRIPTION

DATE

99C-02

**SCALE** 1/4" = 1'0"

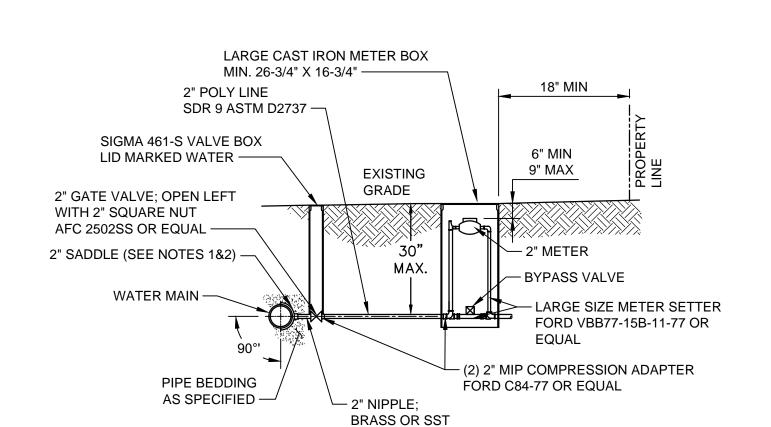

- 1. ALL SERVICES SHALL BE INSTALLED PERPENDICULAR TO MAIN.
- 2. SERVICE SADDLES ON PVC MAINS SHALL BE WIDE BAND BRASS BODY: MCDONALD 3800, FORD S90 (DOUBLE STRAP) OR EQUAL.
- 3. METER BOXES SHALL CONFORM TO ASTM A48, CLASS 30B, AND AASHTO H20 LOADING STANDARDS (OLDCASTLE PRECAST MODEL B1730 OR EQUAL).
- 4. 3" CLEAN FILL REQUIRED ALL AROUND 2" POLY SERVICE LINE.

PROCESS PIPE





ELECTRIC HEATER -

ASSE 1060 ALUMINUM THERMAL

MANUFACTURED BY HOTBOX OR EQUAL, PROVIDE REMOVABLE SIDE PANELS

PLAN VIEW

AS REQD

I. MUST BE MINIMUM 36" AWAY FROM ANY ELECTRICAL PANEL.


VALVE REQUIRED DOWNSTREAM OF BACKFLOW ASSEMBLY.

VERTICAL INSTALLATION SHALL BE DESIGNED AND SUBMITTED TO OWNER

PROTECTIVE ENCLOSURE AS

FOR ACCESS —

FOR APPROVAL.

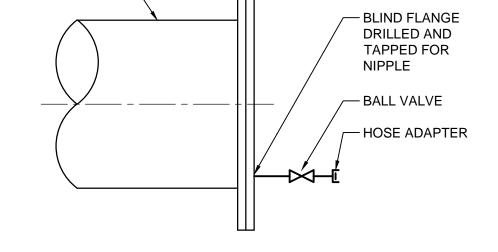

### NOTES:

- 1. USE TAPPING SADDLE OR WELDED BOSS FOR PIPE LESS THAN 6" DIAMETER OR WHEN REQUIRED BY PIPE WALL THICKNESS. USE TAPPING SADDLE ON ALL NON-METALLIC
- 2. PROVIDE 2-INCH FLUSHING CONNECTION.







-FLANGED ADAPTER

OR RESTRAINED

FITTING (TYP)

THERMAL PROTECTIVE

MIN 12" EA SIDE

FLGxFLG


PIPE (TYP)

SPOOL

-FLGxFLG


90° ELL


ENCLOSURE, SIZE AS REQUIRED

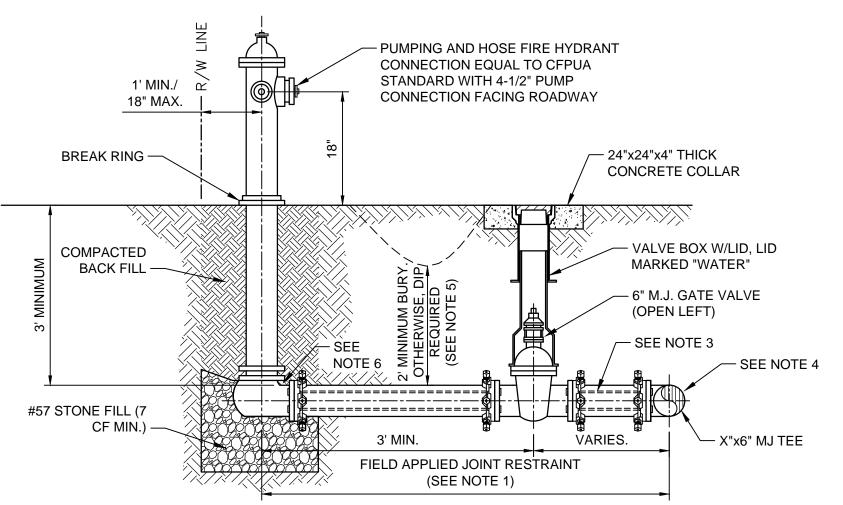


PROJECT MANAGER G. ERIC WILLIAMS, PE

- 1. JOINT RESTRAINT SYSTEMS SHALL BE WEDGE ACTION STYLE FOR DI OR C-900 PVC PIPE AS MANUFACTURED BY EBAA IRON, SIGMA, STAR PIPE PRODUCTS OR APPROVED EQUAL
- 2. WHEN HYDRANT LEGS REQUIRE FULL LENGTH PIPE SECTIONS, OVER BELL RESTRAINT SYSTEM SHALL HAVE 316 STAINLESS STEEL HARNESS AND FASTENERS.
- 3. CONTINUOUS 316 STAINLESS STEEL RODS (TEE TO VALVE AND VALVE TO HYDRANT) MAY BE USED WITH COR-BLUE MJ T-BOLT AND
- GASKET KITS, AS AN ALTERNATIVE. 4. HYDRANT TEE SHALL BE RESTRAINED ON EACH SIDE OF MAIN PLUS ANY VALVE, FITTING, OR JOINT IN MAIN WITHIN 10-FEET OF
- 5. HYDRANT AND VALVE SHALL BE PLACED OUTSIDE DITCH LIMITS.
- 6. WEEP HOLES OPEN AND UNBLOCKED TO DRAIN.

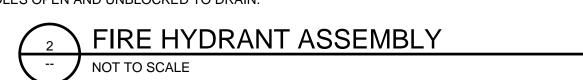

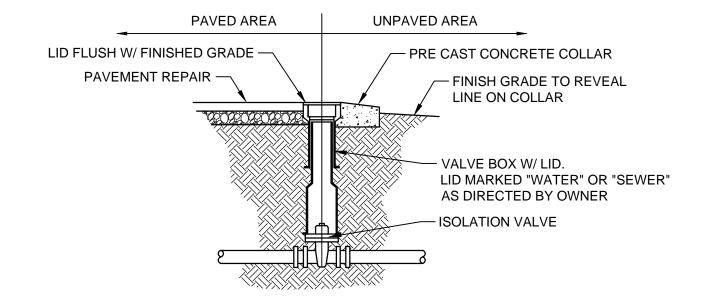



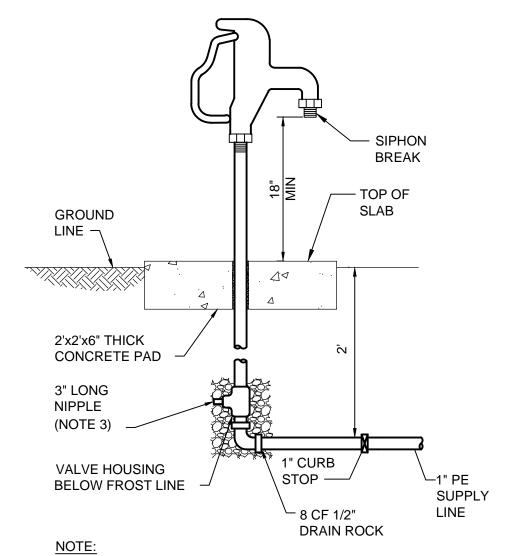

1. NON-FREEZE POST TYPE. 2. HOSE BIBB SHALL ACCOMODATE STANDARD

3/4" GARDEN HOSE.

MATCH DRAIN PORT SIZE PROVIDED BY MANUFACTURER.



HDR Engineering Inc. of the Carolinas NC BELS License # F-0116 101 N. Third Street Wilmington NC, 28401 910-398-9020

			DESIGNED BY	J. VANDENBOSCH, PE
			CHECKED BY	M. KASPER, PE
			DRAWN BY	
			_	
0	10/2018	ISSUED FOR CONSTRUCTION		
ISSUE	DATE	DESCRIPTION	PROJECT NUMBER	100075083
			•	•





— DOUBLE CHECK BACKFLOW

OR APPROVED EQUAL.

8" CONC

SECTION

SLAB

90° ELL W/ SS **NUTS AND BOLTS** 

(TYP)

PREVENTER ASSEMBLY. CLA-VAL, WATTS

- NRS ISOLATION

—FLGxFLG 90° ELL

-PIPE SUPPORT

∕─#4@12" EW

48" MIN


(TYP 2)

IN SLAB CTR

FINISHED GRADE

VALVES

**PUMP STATION #10 REPLACEMENT** 

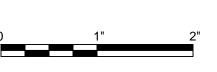



FILENAME 99C-03.dwg

**CIVIL DETAILS** 

**SCALE** 1/4" = 1'0"

SHEET 99C-03

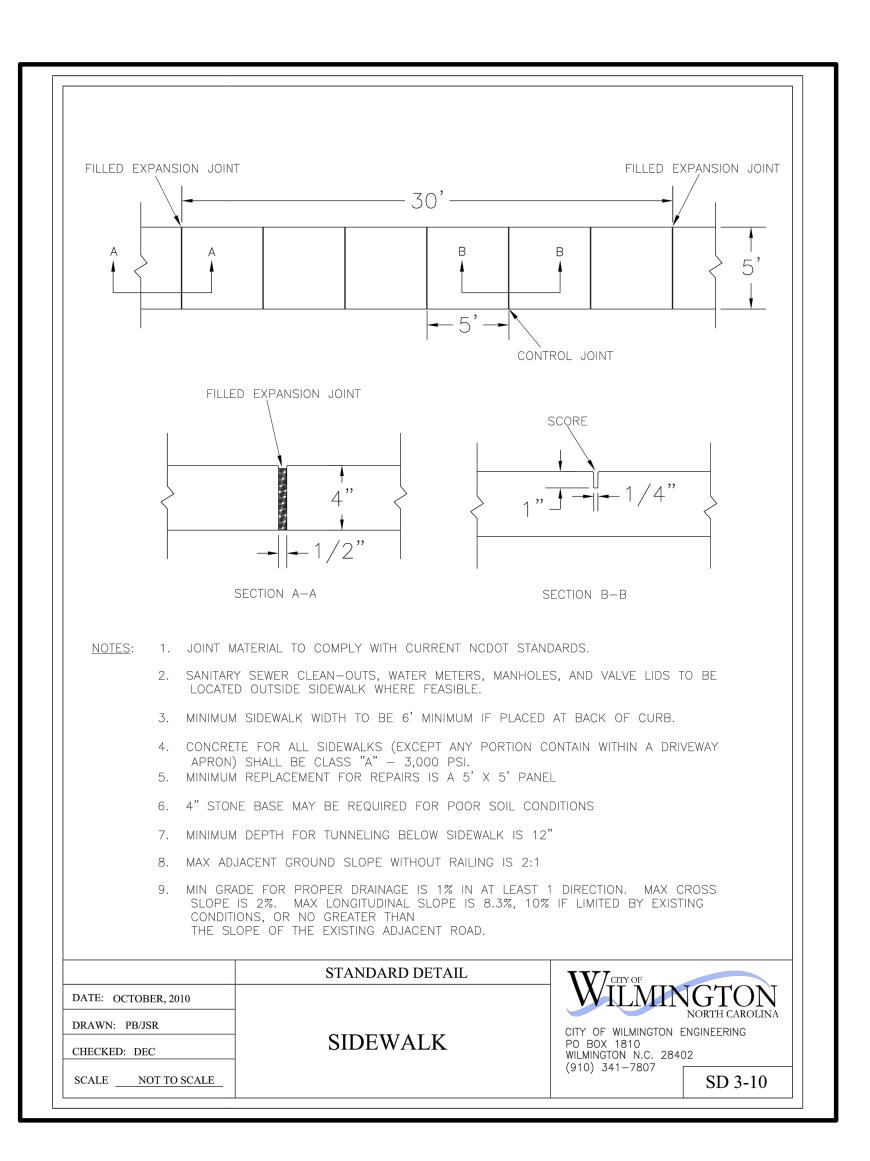

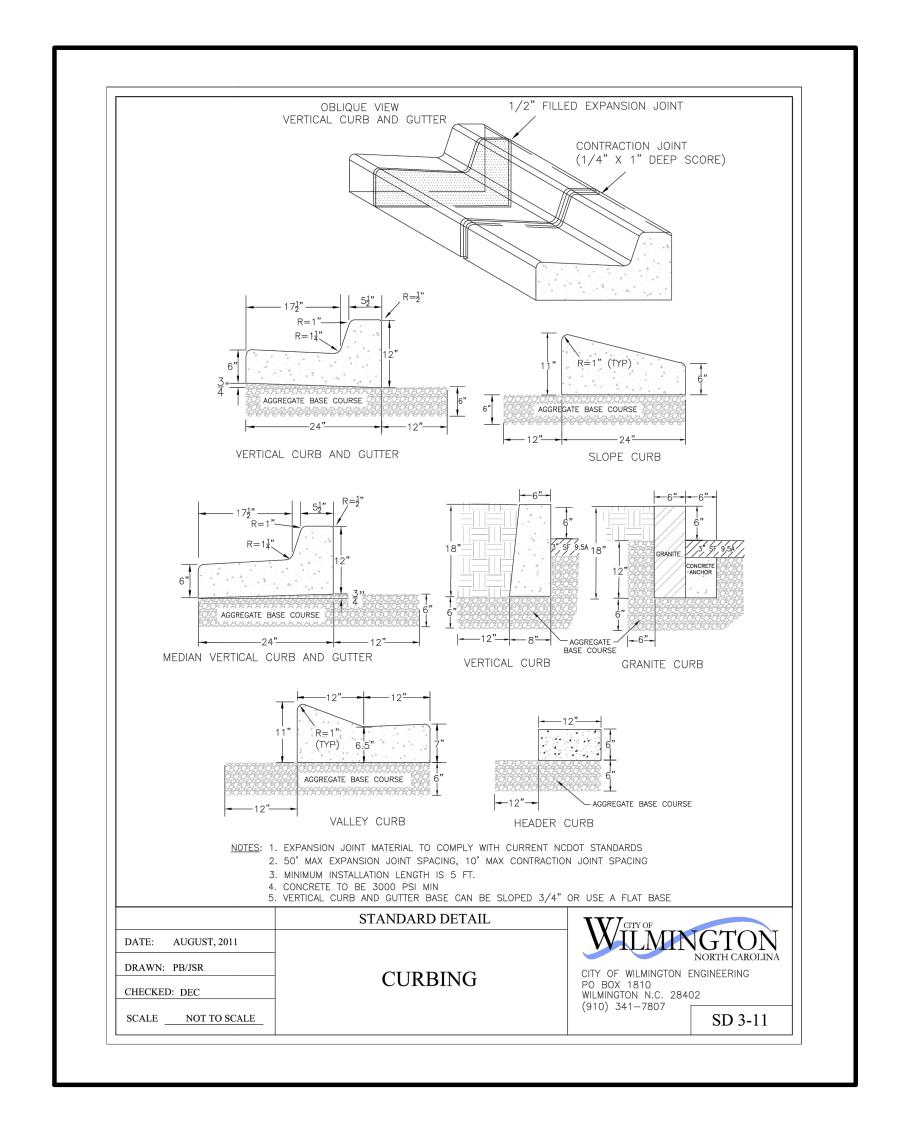





APPROVED CONSTRUCTION PLAN			
	<u>NAME</u>	DATE	
PLANNING		_	
TRAFFIC _			
FIRE			

**CIVIL DETAILS** 

FILENAME 99C-03.dwg **SCALE** 1/4" = 1'0"

SHEET 99C-03

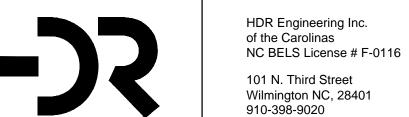

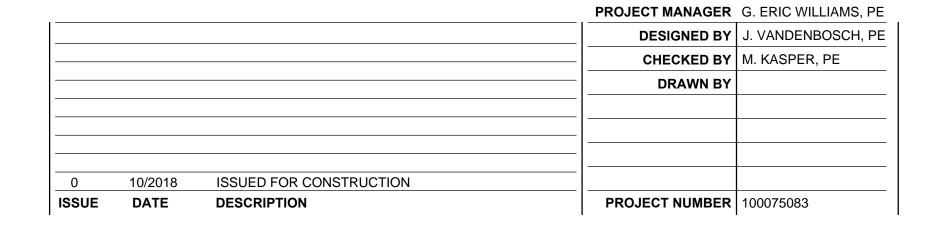





**PUMP STATION #10** 

**REPLACEMENT**